
CHELAN COUNTY NATURAL RESOURCE DEPARTMENT

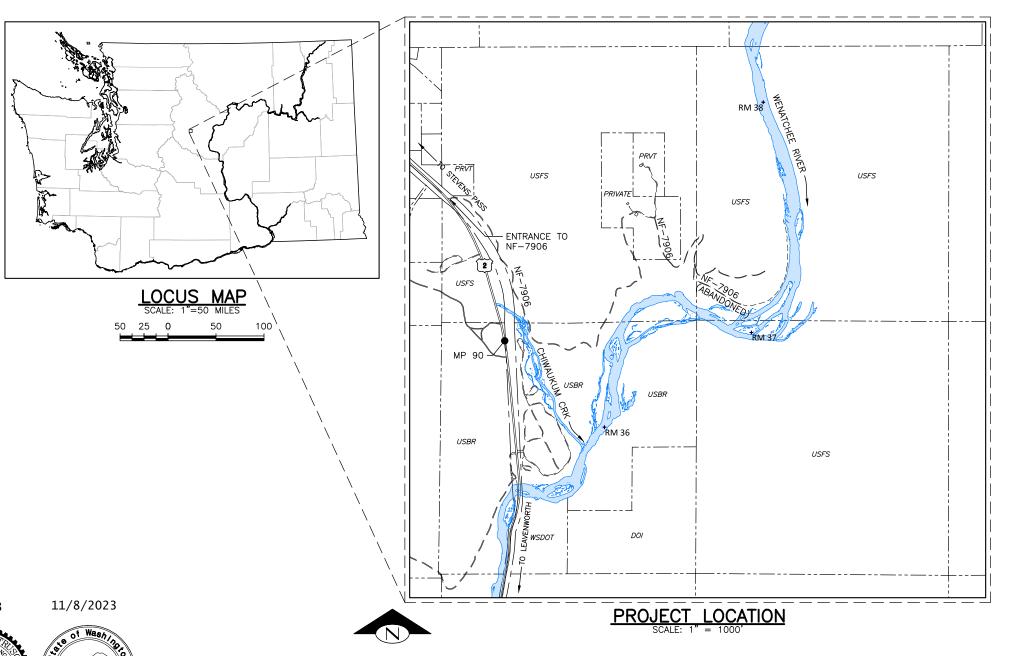

DRAWING LIST

SHEET NO).	SHEET TITLE
1		COVER
2		GENERAL NOTES
3		LEGEND
4		SITE ACCESS
5		PROJECT OVERVIEW
6		PROPOSED PLAN
7		PROPOSED PLAN
8		PROPOSED PLAN
9		HABITAT TREE DETAILS
10		BOULDER CLUSTER DETAILS

CONTACT INFORMATION


NATURAL SYSTEMS DESIGN, INC

1900 N NORTHLAKE WAY, SUITE 211 SEATTLE, WA 98103 (206) 834-0175

CHELAN COUNTY NATURAL RESOURCE DEPARTMENT

411 WASHINGTON STREET, SUITE 201 WENATCHEE, WA 98801 PHONE (509) 667-6533



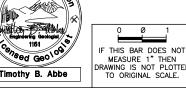







ME OR I	NITIALS AND DATE	GEOGRAPHIC INFORMATION		
SIGNED	NT	LATITUDE	47*41'32"N	
ECKED	RLE	LONGITUDE	120°42'38"W	
AWN			T25N/S03/R17E	
ECKED	GD	DATE	07/15/23	
ECKED	<u> </u>	DATE	077 137 23	

UPPER WENATCHEE RM 37 RESTORATION — HELICOPTER SUPPORT

COVER

1 SHEET 1 OF 10

- 3. MINOR MODIFICATIONS ARE EXPECTED TO SUIT JOB SITE DIMENSIONS OR CONDITIONS. SUCH MODIFICATIONS SHALL BE INCLUDED AS PART OF THE WORK. THE OWNER, ENGINEER AND APPROPRIATE REGULATORY AGENCIES SHALL BE NOTIFIED OF ANY OWNER-AUTHORIZED CHANGE RESULTING IN MORE THAN A 10% DESIGN CHANGE OF PROPOSED FOOTPRINT OR THAT SIGNIFICANTLY AFFECTS THE INTENDED BENEFIT OR FUNCTION OF A PROJECT ELEMENT.
- 4. THE CONTRACTOR SHALL ASSUME SOLE AND COMPLETE RESPONSIBILITY FOR JOB SITE CONDITIONS DURING THE COURSE OF CONSTRUCTION OF THIS PROJECT, INCLUDING SAFETY OF ALL PERSONS AND PROPERTY
- 5. EXISTING UTILITY HAVE NOT BEEN IDENTIFIED AND ANY UTILITY LOCATIONS REPRESENTED SHALL BE CONSIDERED APPROXIMATE. THE CONTRACTOR IS RESPONSIBLE FOR BECOMING FAMILIAR WITH THE PROJECT AREA, ANTICIPATED FLIGHT LINES, ALL UTILITIES, RESIDENCES, AND OTHER INFRASTRUCTURE WHICH MAY BE IMPACTED FROM WORK INCLUDED IN THIS CONTRACT. THE CONTRACTOR BEARS FULL RESPONSIBILITY FOR PROTECTING ALL UTILITIES AND INFRASTRUCTURE AND FOR ENSURING THE SAFETY OF THE PUBLIC
- 6. THE CONTRACTOR SHALL BE RESPONSIBLE FOR IDENTIFYING AND COMPLYING WITH ALL APPLICABLE LAWS, RULES, AND REGULATIONS GOVERNING MANNED AIRCRAFT OPERATION, INCLUDING ANY LOCAL REQUIREMENTS THAT APPLY.

PERMIT NOTES

- 1. EVERY REASONABLE EFFORT SHALL BE MADE TO CONDUCT THE ACTIVITIES SHOWN IN THESE PLANS, IN A MANNER THAT MINIMIZES THE ADVERSE IMPACT ON WATER QUALITY, FISH AND WILDLIFE, AND THE NATURAL ENVIRONMENT
- 2. ALL WORK WILL BE IN COMPLIANCE WITH PERMIT CONDITIONS. IT IS THE CONTRACTOR'S RESPONSIBILITY TO HAVE COPIES OF ALL PERMITS ON THE JOB SITE, UNDERSTAND AND COMPLY WITH ALL PERMIT CONDITIONS.
- 3. IF AT ANY TIME, AS A RESULT OF PROJECT ACTIVITIES, FISH ARE OBSERVED IN DISTRESS, A FISH KILL OCCURS, OR WATER QUALITY PROBLEMS DEVELOP (INCLUDING EQUIPMENT LEAKS OR SPILLS), OPERATIONS SHALL CEASE AND THE OWNER SHALL BE NOTIFIED IMMEDIATELY.
- 4. IF, DURING CONSTRUCTION, ARCHAEOLOGICAL REMAINS ARE ENCOUNTERED, CONSTRUCTION IN THE VICINITY SHALL BE HALTED, AND THE STATE OFFICE OF HISTORIC PRESERVATION AND THE OWNER SHALL BE NOTIFIED IMMEDIATELY.

SURVEY NOTES

- UNLESS NOTED OTHERWISE ON THE PLANS, THE CONTRACTOR SHALL BE RESPONSIBLE FOR THE PROTECTION OF ALL EXISTING SURVEY MONUMENTS AND OTHER SURVEY MARKERS DURING CONSTRUCTION.
- 2. THE CONTRACTOR SHALL MAINTAIN A SET OF PLANS ON THE JOB SHOWING "AS-CONSTRUCTED" CHANGES MADE TO DATE. UPON COMPLETION OF THE PROJECT, THE CONTRACTOR SHALL SUPPLY TO OWNER A SET OF PLANS, MARKED UP TO THE SATISFACTION OF THE OWNER WITH THE APPROVAL OF THE ONSITE ENGINEER, REFLECTING THE AS-CONSTRUCTED MODIFICATIONS.
- 3. LIDAR FOR THIS PROJECT WAS PROVIDED TO THE ENGINEER BY THE CONTRACTING AGENCY AND IS REPRESENTATIVE OF 2022 TOPOGRAPHY AND BATHYMETRIC CONDITIONS. ADDITIONAL TOPOGRAPHIC INVESTIGATION WAS CONDUCTED BY THE ENGINEER IN 2021. THE VERTICAL DATUM IS NAVD88 (FT). THE HORIZONTAL DATUM IS NAD 83 WASHINGTON STATE PLANE NORTH (FT).

CONSTRUCTION NOTES

- 1. CONSTRUCTION HOURS SHALL BE WEEKDAYS BETWEEN 7:00 A.M. AND 6:30 P.M. UNLESS PRIOR APPROVAL IS RECEIVED FROM THE OWNER.
- 2. MATERIAL TO BE TRANSPORTED AND PLACED VIA HELICOPTER WILL BE FURNISHED, PREPARED, AND NEATLY STOCKPILED AT THE HELICOPTER STAGING AREA SHOWN ON THE PLANS.
- 3. THE CONTRACTOR SHALL EXERCISE CARE WHEN TRANSPORTING ALL MATERIAL TO AVOID DAMAGE. WOODY MATERIAL WITH ROOTWADS AND/OR BRANCHES SHALL BE PLACED IN A MANNER THAT MINIMIZES DAMAGE TO BRANCHES, ROOTS, LIMBS, AND TREE TOPS.
- 4. THE CONTRACTOR SHALL MAKE ALL NECESSARY PROVISIONS TO PROTECT EXISTING IMPROVEMENTS, ROADWAYS, DRAINAGE WAYS, BRIDGES, CULVERTS, AND VEGETATION UNTIL SUCH ITEMS ARE TO BE DISTURBED OR REMOVED AS INDICATED ON THE CONTRACT
- 5. THE CONTRACTOR SHALL KEEP THE JOB SITE CLEAN AND HAZARD FREE. UPON COMPLETION OF WORK, CONTRACTOR SHALL REMOVE ALL MATERIAL AND EQUIPMENT NOT SPECIFIED AS REMAINING ON THE PROPERTY.
- 6. ACTIVITIES SHALL BE IMPLEMENTED TO AVOID AND MINIMIZE ADVERSE IMPACTS TO WATERS OF THE UNITED STATES TO THE MAXIMUM EXTENT PRACTICABLE, INCLUDE ACTIONS THAT MINIMIZE THE NUMBER AND EXTENT OF IN-WATER WORK AND EQUIPMENT CROSSINGS OF WETTED

SUMMARY OF QUANTITIES

ITEM #	ITEM DESCRIPTION	QUANTITY	UNIT
1	MOBILIZATION	1	LS
2	TRANSPORT OF WOODY MATERIAL	1	LS
3	PLACEMENT OF WHOLE HABITAT TREES	1	LS
4	BOULDER CLUSTER PLACEMENT	1	LS

11/8/2023



ed Geo Timothy B. Abbe



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TO ORIGINAL SCALE.

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NAME OR INITIALS AND DATE CHECKED DBS CHECKED GD

GEOGRAPHIC INFORMATION

ATITUDE 47°41'32"N

LONGITUDE 120'42'38"W

DATE

TN/SC/RG T25N/S03/R17E

07/15/23


SUPPORT

UPPER WENATCHEE RM 37 RESTORATION - HELICOPTER

GENERAL NOTES

SHEET 2 OF 10


CONSTRUCTION

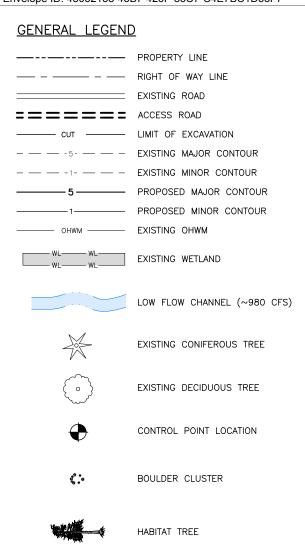

TEMPORARY EROSION CONTROL LEGEND —SB——SB—— SILT BOOM -BN-BLOCK NETS — SILT FENCE — STRAW WATTLE —→——→— DEWATERING LINE DISCHARGE PROPOSED STAGING AREA BULK BAG COFFERDAM TEMPORARY ACCESS ROAD TEMPORARY ACCESS BRIDGE

PUMP DISCHARGE OUTLET


(P) DEWATERING PUMP

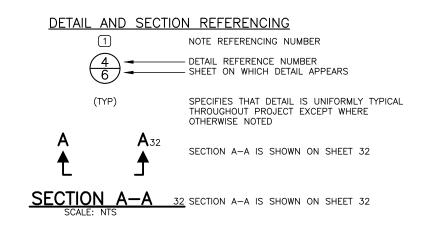


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GEOGRAPHIC INFORMATION LATITUDE 47°41'32"N 07/15/23


SUPPORT


LEGEND

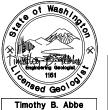3

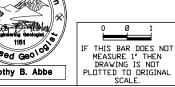SHEET 3 OF 10

UPPER WENATCHEE RM 37 RESTORATION - HELICOPTER LDNGITUDE 120°42'38"W TN/SC/RG T25N/S03/R17E

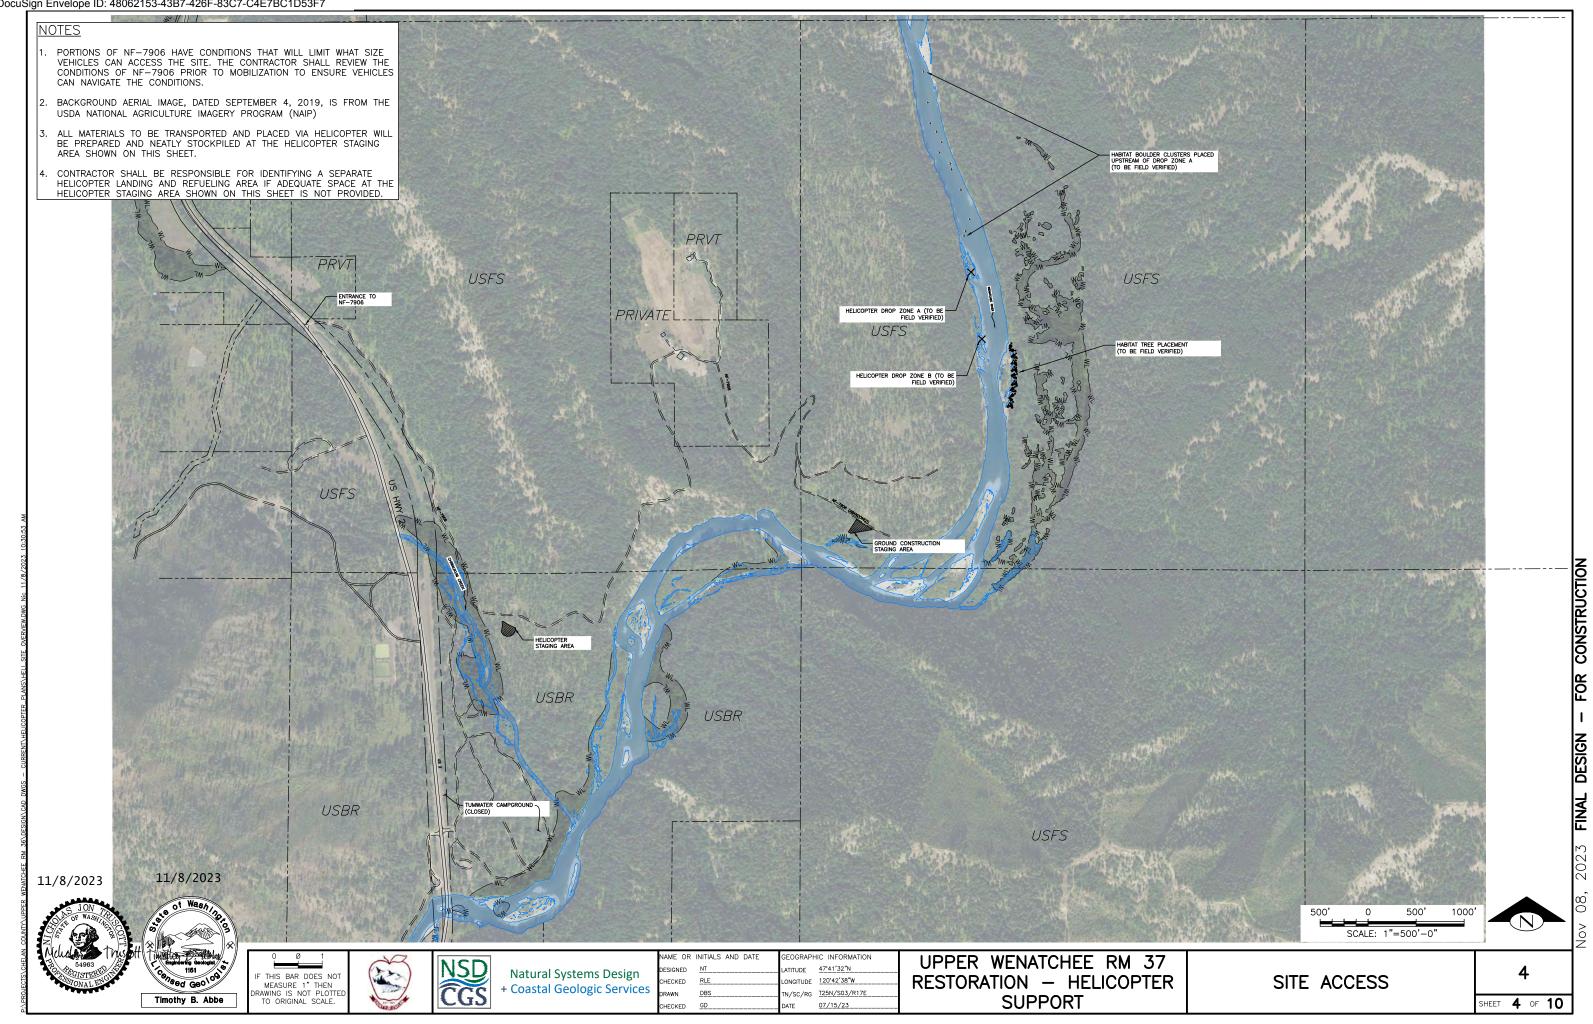

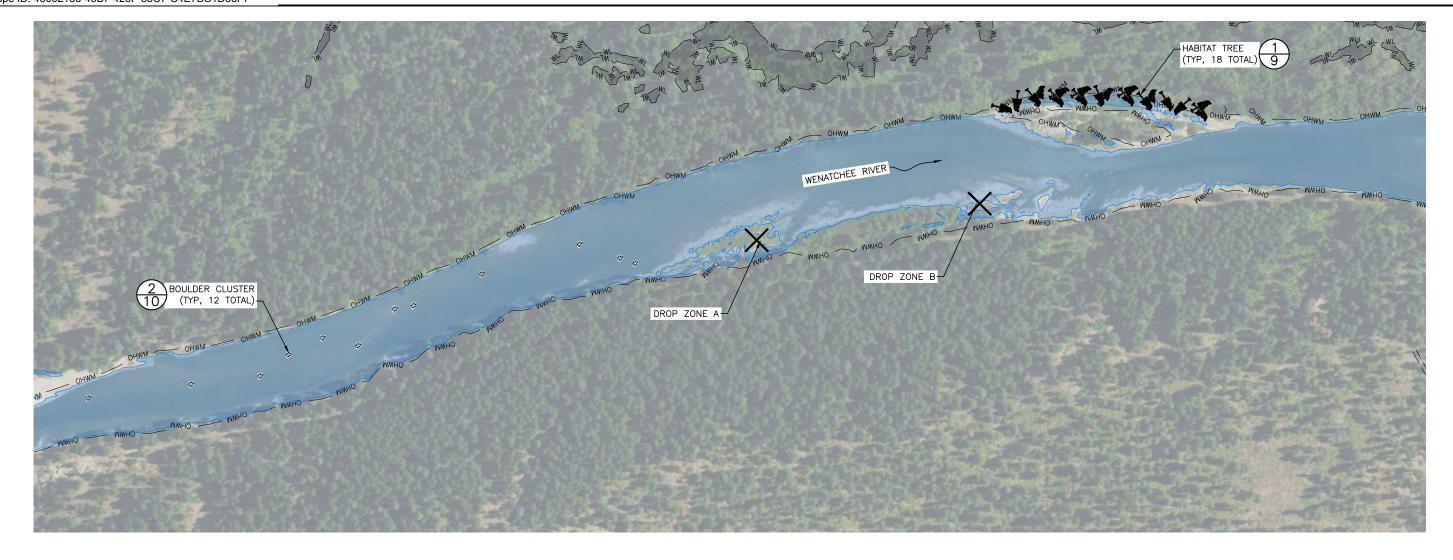


DROP ZONE A LOG DELIVERY SCHEDULE				DROP ZONE B LOG DELIVERY SCHEDULE					
LOG ID	DIA/DBH (IN)	LENGTH (FT)	ROOTWAD (Y/N)	QUANTITY(EA)	LOG ID	DIA/DBH (IN)	LENGTH (FT)	ROOTWAD (Y/N)	QUANTITY(EA)
RD5	20	50	Υ	18	RD4	20	40	Υ	12
D5	20	50	N	3	D4	20	40	N	9
D4	20	40	N	12	D3	20	30	N	9
D3	20	30	N	12	E2	16	20	N	12
E2	16	20	N	12	RACKING BUNDLE	36 TO 48	20 TO 40	Y/N	30
PACKING BUNDLE	36 TO 48	20 TO 40	Y /N	30					

- PRIOR TO EXECUTION OF WORK IN THIS CONTRACT, LOG SORTING AND STOCKPILING AND BOULDER PREPARATION WILL BE COMPLETED BY OTHERS.
- 2. MATERIALS TO BE PLACED IN DROP ZONES A AND B SHALL BE STAGED ON EXPOSED BARS. EXACT LOCATIONS TO BE VERIFIED IN THE FIELD BASED ON SITE CONDITIONS.
- 3. OVERHEAD UTILITIES AND TRANSMISSION LINES ARE NOT SHOWN ON THESE PLANS; CONTRACTOR SHALL BE RESPONSIBLE FOR IDENTIFYING AND AVOIDING DAMAGE TO ALL OVERHEAD UTILITIES.

HABITAT STRUCTURE DELIVERY SCHEDULE

LOG ID	DIA/DBH (IN)	LENGTH (FT)	ROOTWAD (Y/N)	QUANTITY(EA)	
HABITAT TREE	VARIES	VARIES	Υ	18	
BOULDER	TYPE 5/TYPE 6			54	



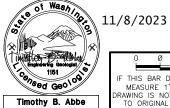

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₹S	Natural Systems Design + Coastal Geologic Service
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IAME OR	INITIALS AND DATE	GEOGRAPH	IC INFORMATION
ESIGNED	NT	LATITUDE	47*41'32"N
HECKED	RLE	LONGITUDE	120°42'38"W
RAWN	DBS	TN/SC/RG	T25N/S03/R17E
HECKED	GD	DATE	07/15/23

UPPER WENATCHEE RM 37 RESTORATION - HELICOPTER **SUPPORT**

5

SHEET **5** OF **10**

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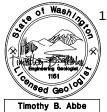
PROJECT OVERVIEW

SCALE: 1"=150'-0"

<u>NOTES</u>

- 1. BOULDER CLUSTERS TO BE PLACED VIA HELICOPTER.
- 2. BOULDER PREPARATION TO BE COMPLETED BY OTHERS PRIOR TO EXECUTION OF WORK IN THIS CONTRACT.
- 3. BOULDERS SHALL BE HOISTED AND PLACED SUCH THAT NO CABLE OR OTHER LIFTING AIDS REMAIN ATTACHED WHEN PLACED.
- 4. BOULDERS SHALL NOT BE TOUCHING WHEN PLACED; SEE DETAIL ON SHEET 10.
- 5. LOCATIONS SHOW ARE APPROXIMATE AND WILL BE ADJUSTED IN THE FIELD BY THE ENGINEER.
- 6. OVERHEAD UTILITIES AND TRANSMISSION LINES ARE NOT SHOWN ON THESE PLANS; CONTRACTOR SHALL BE RESPONSIBLE FOR IDENTIFYING AND AVOIDING DAMAGE TO ALL OVERHEAD UTILITIES.





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GEOGRAPHIC INFORMATION

LATITUDE 47*41'32"N

LONGITUDE 120'42'38"W

TINISCIRG T25N/S03/R17E

DATE 07/15/23

UPPER WENATCHEE RM 37 RESTORATION — HELICOPTER SUPPORT

PROPOSED PLAN


SCALE: 1"=40'-0"

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SHEET **6** OF **10**

FINAL DESIGN - FOR CONSTRUCTION

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Timothy B. Abbe

11/8/2023
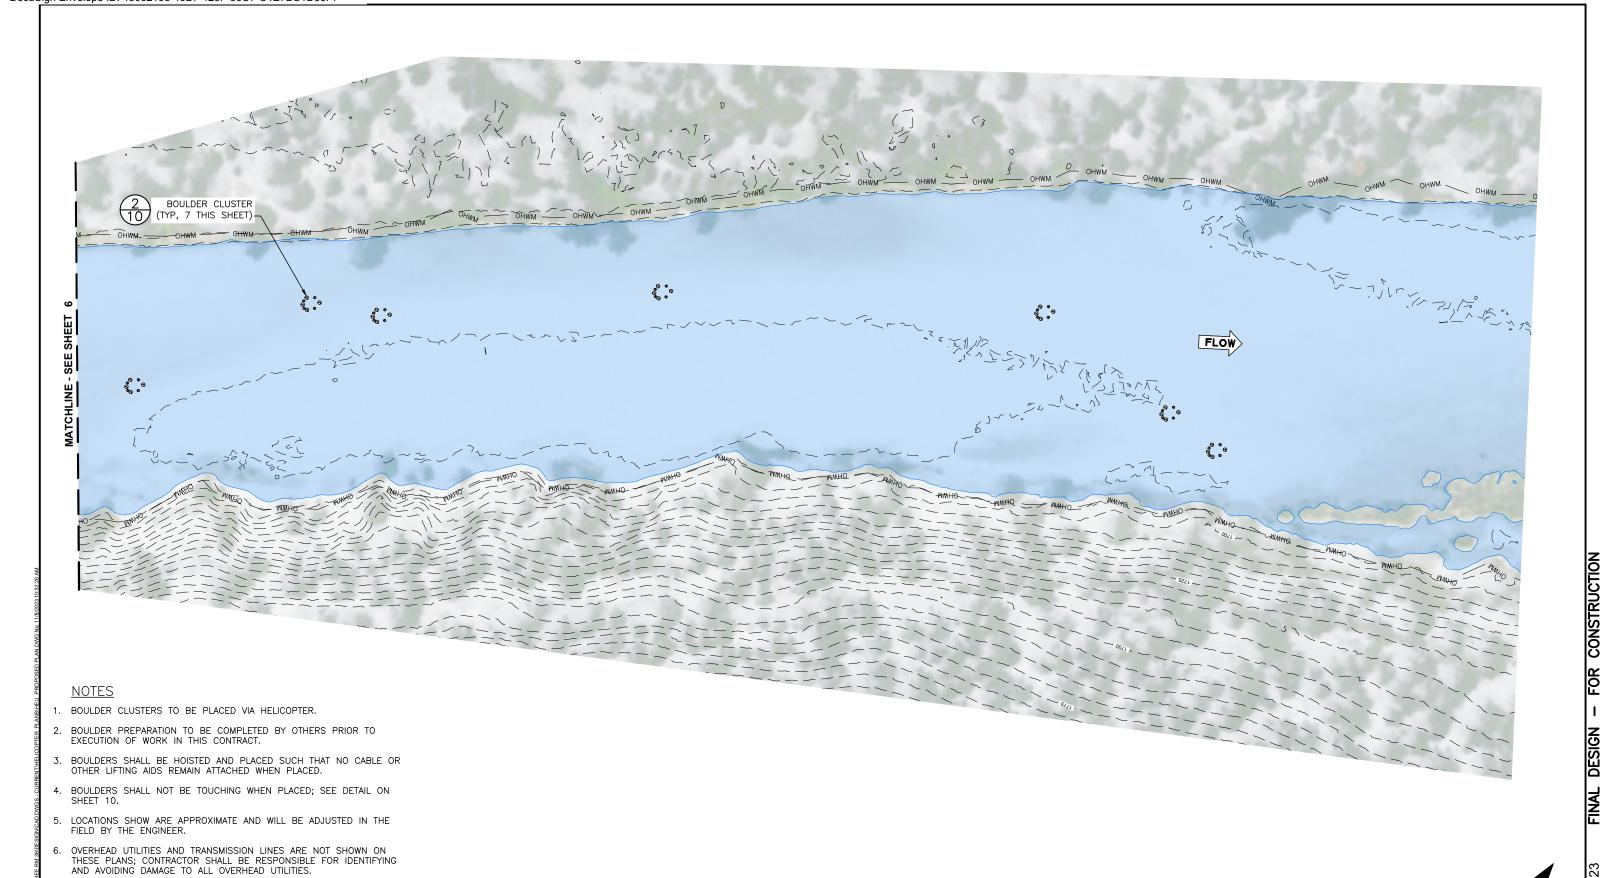
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+ Coastal Geologic Services

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LATITUDE 47'41'32"N

LONGITUDE 120'42'38"W

TN/SC/RG T25N/S03/R17E

DATE 07/15/23

OGRAPHIC INFORMATION

UPPER WENATCHEE RM 37
RESTORATION — HELICOPTER
SUPPORT

PROPOSED PLAN

SCALE: 1"=40'-0"

7 05

SHEET **7** OF **10**

<u>NOTES</u>

- 1. HABITAT TREES TO BE PLACED VIA HELICOPTER.
- 2. HABITAT TREE PREPARATION TO BE COMPLETED BY OTHERS PRIOR TO EXECUTION OF WORK IN THIS CONTRACT.
- 3. LOCATIONS SHOW ARE APPROXIMATE AND WILL BE ADJUSTED IN THE FIELD BY THE ENGINEER.
- 3. PLACE TREES TO MAXIMIZE ENTANGLEMENT WITH EXISTING STABLE VEGETATION AND TREES. WHERE POSSIBLE, PLACE TREES BETWEEN EXISTING TREES TO RESIST MOBILIZATION IN MULTIPLE DIRECTIONS.
- 4. TREES SHALL BE PLACED AS TO MINIMIZE DISTURBANCE TO EXISTING VEGETATION; SEE DETAIL ON SHEET 9.
- 5. OVERHEAD UTILITIES AND TRANSMISSION LINES ARE NOT SHOWN ON THESE PLANS; CONTRACTOR SHALL BE RESPONSIBLE FOR IDENTIFYING AND AVOIDING DAMAGE TO ALL OVERHEAD UTILITIES.





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GEOGRAPHIC INFORMATION

LATITUDE 47*41'32"N

LONGITUDE 120'42'38"W

TN/SC/RG T25N/S03/R17E

DATE 07/15/23

UPPER WENATCHEE RM 37 RESTORATION — HELICOPTER SUPPORT


PROPOSED PLAN


SCALE: 1"=40'-0"

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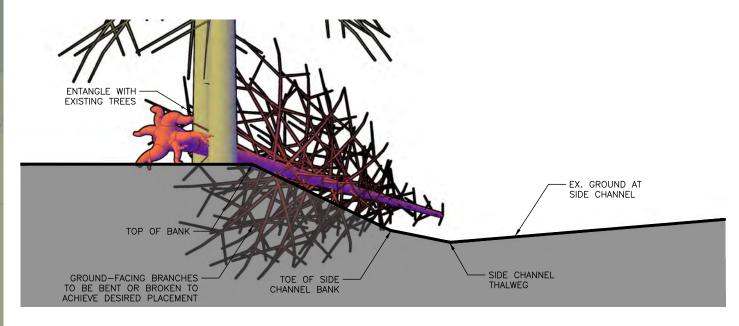
SHEET **8** OF **10**

FINAL DESIGN - FOR CONSTRUCTION



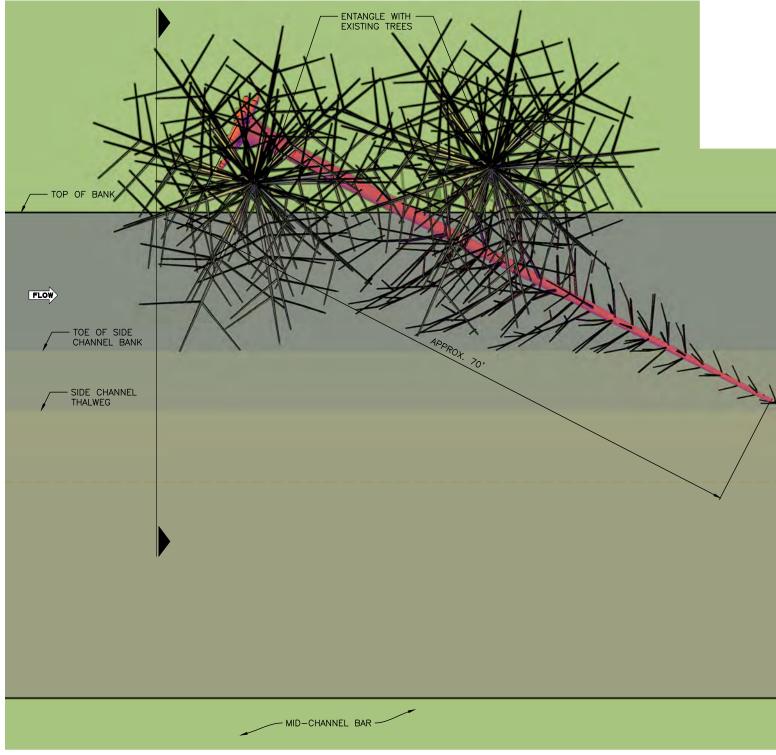

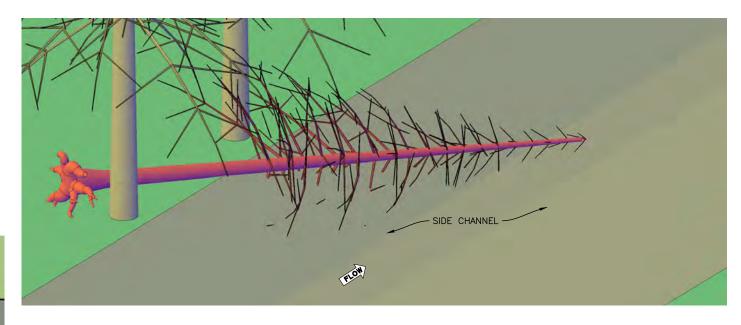HABITAT TREE ISOMETRIC




HABITAT TREE ELEVATION SCALE: 1" = 4'

- 1. TREES SHALL BE PLACED BY HELICOPTER, WITH MANUAL GROUND
- 2. PLACE TREES TO MAXIMIZE ENTANGLEMENT WITH EXISTING STABLE VEGETATION AND TREES. WHERE POSSIBLE, PLACE TREES BETWEEN EXISTING TREES TO RESIST MOBILIZATION IN MULTIPLE DIRECTIONS.
- 3. TREES SHALL BE PLACED SINGLY OR IN TANDEM, DEPENDING ON SITE CONDITIONS. PLACE TREES AS SHOWN IN THESE PLANS, OR AS DIRECTED IN THE FIELD.
- 4. TREES SHALL BE PLACED AS TO MINIMIZE DISTURBANCE TO EXISTING VEGETATION.
- 5. HABITAT TREES ARE ESTIMATED TO WEIGH UP TO 8,000 POUNDS. IF NECESSARY, TRIMMING OF TREE LIMBS, BRANCHES, AND TOP WILL BE PERFORMED BY OTHERS TO REDUCE WEIGHT BELOW 8,000 POUNDS.



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ORIGINAL SCALE.

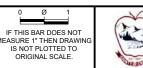

Natural Systems Design - Coastal Geologic Services

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EOGRAPHIC INFORMATION 47*41'32"N ONGITUDE 120°42'38"W I/SC/RG T25N/S03/R17E 07/15/23


UPPER WENATCHEE RM 37 RESTORATION - HELICOPTER **SUPPORT**

HABITAT TREE DETAILS


9

SHEET **9** OF **10**

- BOULDER PREPARATION AS SHOWN ON THIS SHEET WILL BE PERFORMED BY OTHERS PRIOR TO EXECUTION OF WORK IN THIS CONTRACT
- 2. EACH BOULDER WILL BE TESTED INDIVIDUALLY BY OTHERS TO ENSURE ADEQUATE PREPARATION.
- 3. BOULDERS SHALL BE HOISTED AND PLACED INDIVIDUALLY. HOIST, TRANSPORT, AND PLACE BOULDERS WITH CARE, AVOIDING SHOCK LOADING TO THE HOIST LINE AND IMPACTS TO THE BOULDER.
- 4. CONTRACTOR SHALL COORDINATE WITH GROUND SUPPORT CONTRACTOR TO DEVELOP A HOISTING METHOD WHICH ALLOWS USE OF THE PREPARATION METHOD SHOWN ON THIS SHEET, OR ANOTHER METHOD APPROVED BY THE CONTRACTING OFFICER, TO HOIST AND PLACE BOULDERS SUCH THAT NO CABLE OR OTHER LIFTING AIDS REMAIN ATTACHED WHEN PLACED. IF USING EYEBOLT, EYEBOLT MAY REMAIN IN BOULDER.
- 5. PLACE BOULDERS AS SHOWN ON THIS SHEET, LEAVING APPROXIMATELY 5 TO 8 FEET BETWEEN EACH BOULDER IN ITS FINAL POSITION.
- 6. LOCATIONS FOR INDIVIDUAL BOULDERS WILL BE IDENTIFIED IN THE FIELD BY THE CONTRACTING OFFICER.

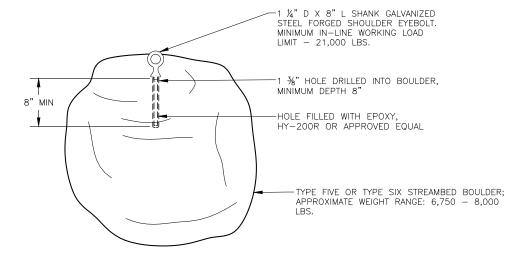



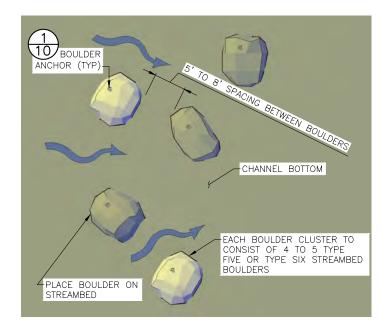

BOULDER CLUSTER 2 NOT TO SCALE 10

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CHECKED GD

ME OR INITIALS AND DATE

GEOGRAPHIC INFORMATION

LATITUDE 47*41'32"N

LONGITUDE 120'42'38"W

TN/SC/RG T25N/S03/R17E

DATE 07/15/23

UPPER WENATCHEE RM 37 RESTORATION — HELICOPTER SUPPORT

BOULDER CLUSTER DETAILS

10

SHEET 10 OF 10